

Grading Permit Application Packet

<u>PLEASE NOTE</u>: All Land disturbance of areas greater than one acre, or less than one acre and part of a common plan of development greater than one acre require a Grading Permit. See Section 4 of the Erosion and Sediment Control ordinance for additional exceptions to the Grading Permit requirement.

The Grading Application Packet contains:

- Attachment A Grading Permit Fee and Bond Fee Schedule;
- Attachment B Application for Grading Permit;
- Attachment C ADEM's NPDES Construction General Permit (Permit No. ALS100000) Information;
- Attachment D Typical Erosion and Sediment Control details for Construction of Single Family Residence;
- Attachment E Checklist guide for preparation of an Erosion and Sediment Control Plan;
- Attachment F Corporate Surety Bond forms (only one of two required) to be completed by your bonding company; and,
- Attachment G Site Clearing, Earthwork, Grading and other Site Activity Letter of Credit Form.

Grading Permit Application Instructions:

Fill out the Application ENTIRELY. Do not leave any blank lines. An incomplete or inaccurate application shall not be accepted and will delay the application review process.

Property Location:

- Include the Tax Parcel I.D. (County Tax Map) number(s) available from the land records or the Real Estate Tax Map.
- Calculate an accurate estimate of the total disturbed acres rounded up to the nearest whole acre. The total disturbed acres shall be used to calculate the bond amount.
- Examples for the Description of Work and Proposed Use may include but are not limited to: water and sewer utility, residential subdivision, commercial development, neighborhood playground, single family residence, etc.

Contact Information:

• Provide contact information for Property Owner, Site Supervisor and QCP. Copies of all inspections, warnings, compliance order, stop work orders, violations and abatement or remediation orders shall be maintained by the Property Owner and made available upon request.

Owner and Applicant Signatures:

- The Application SHALL be signed by the Property Owner or authorized agent. If the Application is signed by an authorized agent, documentation delegating the authorized agent to sign on the Property Owners behalf shall accompany the Application.
- Include Letters of Permission for any related off-site land disturbance.
- Provide documentation that the proposed development has obtained coverage under the Alabama Department of Environmental Management (ADEM) National Pollutant Discharge Elimination Systems (NPDES) Construction General Permit. Information regarding the Construction General Permit is provided on ADEM's website:

www.adem.state.al.us/programs/water/constructionstormwater.cnt.

Submit the application to the City of Prattville Annex Building, Permits Counter, 102 West Main Street, Prattville, Alabama 36067:

Submittal Requirements:



Grading Permit Application Packet

Submittal Requirements:

One or Two Family Residential Construction (Submit to Building Department):

- Application Grading Permit
- Application Fee
- Applicable supporting documentation
- Erosion and Sediment Control Plan

The City of Prattville Building Department shall contact you with comments to be addressed, fees to be paid, or written approval.

All Other Construction (Submit to Planning Department):

- Application Grading Permit
- Application Fee
- Applicable supporting documentation
- Erosion and Siltation control bond estimate based on the total disturbed area (see enclosed Fees and Bond schedule)
- Complete set of digital and 36" by 24" hard copy plans which include the Erosion and Sediment Control Plan (in a Phase I and Phase II format, only if necessary by the projects complexity)

The City of Prattville Planning Department shall contact you with comments to be addressed, fees to be paid, or written approval.

Bonding

Upon written grading plan approval notification by the City, please submit your bond (or letter of Credit) documents and surety to the City of Prattville, Planning Department, 102 West Main St., Prattville, Alabama 36067.

Provide a copy of your grading plan approval letter and the appropriate collateral in the form of:

- 1) Cashiers or certified check (a W-9 form and e-verify is required with all cash submittals);
- 2) A Letter of Credit; or,
- 3) Corporate Surety Bond, for the amounts specified on the approval letter or Grading Permit Application.

Upon the City's approval of the bond, the Planning Department shall contact the applicant within ten (10) workdays of receipt of a complete plan submission with comments or plan approval. *The Grading Permit shall be issued upon plan approval*.

Pre-Construction Meeting:

- Only, if stated in the City's approval letter, an onsite pre-construction meeting is required prior to any land disturbance:
- A City Stormwater inspector shall contact the applicant within ten (10) workdays to schedule the preconstruction meeting. *The Grading Permit shall be issued at the Pre-Construction Meeting*
- The pre-construction meeting requires:
 - 1) Clearing limits shall be flagged prior to the meeting;
 - 2) Provide documentation of coverage under ADEMs NPDES Construction General Permit, if required; and.
 - 3) Attendance of the site superintendent, clearing and/or grading contractor and any companies responsible for site inspections and/or BMP installation.



Attachment A

Grading Permit Fee and Bond Schedule Fee



GRADING PERMIT AND BOND FEES

Grading Permit Fee:	
Permit Application Fee Commercial (Development Plans, DP) Subdivisions and Infrastructure Plans	\$400.00
One or Two Family Residential Units	\$150.00
Bond Amounts Required For Developn	nent:
Clearing Operations Only	\$1,000 per acre or fraction of disturbed
Earthwork or Clearing and Earthwork Operations	\$3,000 per acre or fraction of disturbed
Note: Inspections for project completion includes one punch list i additional inspections are required to verify the project is complete.	*

COMMENT:

• In general, all Development Plans (DPs) are considered commercial projects and the bonds are calculated on total disturbed acreage.

inspection fee is required for each additional inspection.

- Construction Plans and Profiles (CPAP) and infrastructure projects bonds are calculated on total disturbed acreage.
- One or two family residential construction is required to apply for a separate grading permit from the subdivision plans. One or two family residential construction shall not be required to obtain a bond for the disturbed area.
- Any project which is submitted as a Rough Grading" or Temporary Stockpile permit shall also have to apply for an additional grading permit and bond upon final grading plan approval.

*EXAMPLE BOND CALCULATION: For a project that is disturbing 4.42 acres (or rounded to 5 acres), the fee would be calculated as: $(5 \times \$3,000) = \$15,000.00$ Total Bond Amount



Attachment B

Application for Grading Permit

APPLICATION – GRADING PERMIT

City of Prattville Annex Building 102 W. Main Street, Prattville, Alabama 36067 (334)595-0400, FAX (334)361-3677, building@prattvilleal.gov



Property Location and General Information						
Project Name:						
Site Location / Ad	ddress:					
Subdivision:					Block:	
Tax Parcel ID:						
Description of Wo	ork & Proposed Us	e:				
Disturbed Area:	Estimated Bond	Type of Permit:	Type of Project:			
Aaraa	Amount:	☐ Grading and/or Ea	ırthwork	☐ One or Two Family Residential (Single Lo		
Acres		☐ Clearing Only		☐ Other Construction	(Development)	
		Owner Contac	t Inforn	nation		
Property Owner:			Compa	ny:		
Address:			•			
City:			State:		Zip Code:	
E-mail:			Phone:			
		Site Supervisor Co	ontact Ir	nformation		
Site Supervisor:			Company:			
Address:			_			
City:			State:		Zip Code:	
E-mail:			Phone:			
		QCP Contact	Inform	ation		
QCP:			Compa	ny:		
Address:						
City:			State:		Zip Code:	
E-mail:			Phone:			
		Regulatory R	equiren	nents		
NPDES Permit R	equired? \Box Y	es 🗆 No	NPDES	Permit No.:		
CBMP Plan Attac CBMP Narrative		es □ No es □ No		rd ESC Details Used? rd ESC Details Attached?	☐ Yes ☐ No ☐ Yes ☐ No	
Notes:						

APPLICATION – GRADING PERMIT

City of Prattville Annex Building 102 W. Main Street, Prattville, Alabama 36067 (334)595-0400, FAX (334)361-3677, building@prattvilleal.gov



Certification

AMEND APPLICATION. TRANSFER GRADING PERMIT:

An approved Grading Permit shall not expire unless there are changes to the project which may affect the quantity and/or quality of storm water runoff. Grading Permit may be amended or transferred according to Article 1, Division 1, Section 10 of the City of Prattville Illicit Discharge Detection and Elimination (IDDE) Procedures Ordinance.

RIGHT OF ENTRY:

I hereby grant designated officials of City of Prattville the right to enter my property for the purpose of inspection or monitoring for compliance with the approved erosion and sediment control plan on the above referenced project.

PLAN IMPLEMENTATIONS:

I certify that I fully understand and will comply with all City of Prattville Erosion and Sediment Control Program requirements and the *Alabama Handbook for Erosion, Sediment Control and Stormwater Management on Construction Sites* or industry standards as accepted by ADEM. I will carry out the erosion and sediment control plan on the above referenced project as approved by the City of Prattville. I will keep a copy of the most current Alabama Handbook or field manual and one set of the approved Erosion Control Plan on the referenced site at all times.

Owner and Applicant Signatures

I certify, under penalty of law, that this document and all attachments were prepared under my direction or supervision, and I am familiar with, the information in this document and such attachments. Based on my inquiry of those individuals immediately responsible for obtaining the information or of the Qualified Credentialed Professional responsible for preparing any portion of the application or correspondence, I believe the submitted information is true, accurate and complete. I am aware that there are significant penalties for submitting false information, including the possibility of fine and civil penalty. I am fully aware and understand that no certificate of occupancy or final plat shall be issued until all grading requirements are met as required by the City.

Printed Name and Title of Applicant	Signature of Applicant	Date
Printed Name and Title of Owner	Signature of Owner (Required)	 Date
Finited Name and Title of Owner	Signature of Owner (Required)	Date

Permit Number: Project Approved? ☐ Yes ☐ No Date: Print Name of Approver Bond/Check Amount: Department Bond/Check Number: Signature of Approver Date

Note: Shaded portion for City of Prattville use only



Attachment C

ADEM's NPDES Construction General Permit (Permit No. ALS100000) Information



Grading Permit Application Packet

ADEM - Construction General Permit

http://www.adem.state.al.us/programs/water/constructionstormwater.cnt

The Clean Water Act and Federal regulations require construction site operators to obtain NPDES permit coverage for regulated land disturbances and associated discharges of stormwater runoff to State waters.

Effective April 1, 2011, ADEM established General NPDES Permit No. ALR100000 for discharges associated with regulated construction activity that will result in land disturbance equal to or greater than one acre or from construction activities involving less than one acre and which are part of a common plan of development or sale equal to or greater than one acre.

Construction site operators / owners seeking coverage under this general permit must submit a Notice of Intent (NOI) in accordance with the permit requirements.

Operators / owners of all regulated construction sites must implement and maintain effective erosion and sediment controls in accordance a Construction Best Management Practices Plan (CBMPP) prepared and certified by a Qualified Credentialed Professional (QCP). For priority construction sites, which include any site that discharges to (1) a waterbody which is listed on the most recently EPA approved 303(d) list of impaired waters for turbidity, siltation, or sedimentation, (2) any waterbody for which a TMDL has been finalized or approved by EPA for turbidity, siltation, or sedimentation, (3) any waterbody assigned the Outstanding Alabama Water use classification in accordance with ADEM Admin. Code r. 335-6-10-.09, and (4) any waterbody assigned a special designation in accordance with ADEM Admin. Code r. 335-6-10-.10, the CBMPP must be submitted to ADEM for review along with the NOI.

A QCP or Qualified Credentialed Inspector (QCI) conduct regular inspections of regulated construction activities to ensure effective erosion and sediment controls are being maintained. In certain circumstances, the QCI or QCP must also monitor construction site discharges for turbidity.

On December 1, 2009, the U.S. Environmental Protection Agency (EPA) published effluent limit guidelines (ELGs) and new source performance standards (NSPS) for regulated construction sites. The regulation was effective on February 1, 2010. After this date, all permits issued by EPA or states must incorporate the final rule requirements. Although certain parts of the rule were since stayed, ADEM's general permit incorporates those non-numeric effluent limits promulgated by EPA and which remain in effect.

Alabama Construction General Permit, April 1, 2016

http://www.adem.state.al.us/programs/water/waterforms/ALR16CGP.pdf

Construction General Permit Forms (Form will automatically download to "Downloads" folder)

CGP - Draft Notice of Intent

www.adem.state.al.us/programs/water/waterforms/DraftCSW-CGP-NOI.pdf

CGP - Inspection Report

www.adem.state.al.us/programs/water/waterforms/CSW-CGP-InspectionReport.pdf

CGP - Notice of Noncompliance

www.adem.state.al.us/programs/water/waterforms/CSW-CGP-Noncompliance.pdf

CGP - Termination Request

www.adem.state.al.us/programs/water/waterforms/CSW-CGP-NOT.pdf

NOW AVAILABLE: eNOI https://app.adem.alabama.gov/eNOI/

ADEM's construction general permit requires the registrant to post and maintain facility identification. The registrant is required to post a sign at easily accessible location(s) to identify the site. The registrant may use this example sign or create and use a sign with equivalent identifying information.



Grading Permit Application Packet

Example Facility ID Sign

www.adem.state.al.us/programs/water/waterforms/CSW-CGP-FacilitySignExample.doc

Permit Fee Schedule D

www.adem.state.al.us/programs/water/waterforms/FeeScheduleD.pdf

Updated ADEM CBMPP Template

www.adem.state.al.us/programs/water/waterforms/CSW-CBMPPTemplate.pdf

AL Handbook for Erosion Control, Sediment Control and Stormwater management on Construction Sites and Urban Areas

https://alconservationdistricts.gov/resources/erosion-and-sediment-control/

Low Impact Development Handbook for the State of Alabama

www.adem.state.al.us/programs/water/waterforms/LIDHandbook.pdf

Priority Construction Sites

Construction sites discharging directly to these waters, and those within any identified watershed areas, will be required to submit a CBMPP with any request for permit coverage. For waters where only the stream segment is identified, ADEM may still, on a case-by-case, designate sites within the surrounding watershed as priority construction sites. Contact the Department for additional guidance.

Construction Stormwater GIS Files

www.adem.state.al.us/programs/water/waterforms/csw2014.zip

Alabama 303(d) list of Impaired Waters

http://adem.alabama.gov/programs/water/303d.cnt

Information on Alabama TMDLs

http://adem.alabama.gov/programs/water/tmdl.cnt

Qualified Credentialed Inspector Training

www.adem.state.al.us/programs/water/waterforms/QCPQCIProg.pdf

ADEM currently recognizes the following QCI Training Programs:

Homebuilders Association of Alabama (HBAA)

HBAA Qualified Credentialed Inspector (QCI) training program

Thompson Engineering, Inc. (TEI)

Thompson Engineering, Inc. (TEI) Qualified Credentialed Inspector (QCI) training program

Contact Information

Mailing Address

ADEM

Attn: Water Division
Stormwater Management Branch
Post Office Box 301463
Montgomery, Alabama 36130-1463
(334) 271-7700
(334) 279-3051 Fax
cswmail@adem.state.al.us

Physical Address

ADEM


Attn: Water Division Stormwater Management Branch 1400 Coliseum Boulevard Montgomery, Alabama 36110 (334) 271-7700 (334) 279-3051 Fax


cswmail@adem.state.al.us



Attachment D

Typical Erosion and Sediment Control details for Construction of Single Family Residence

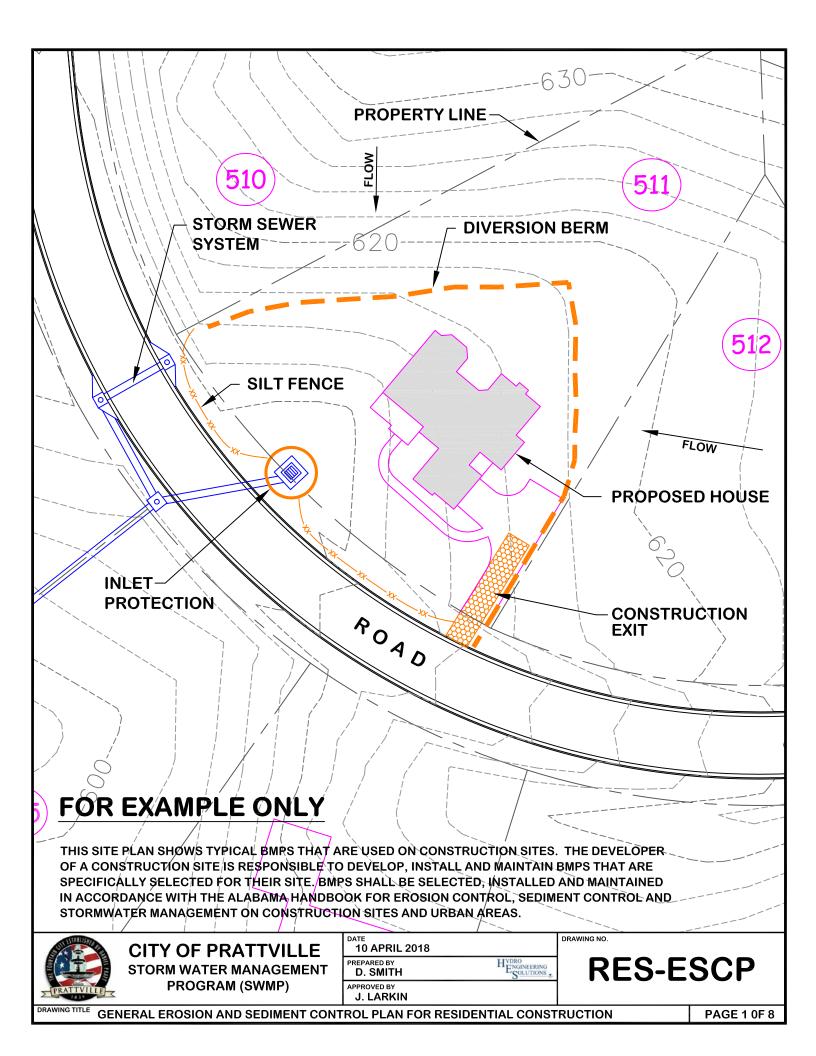

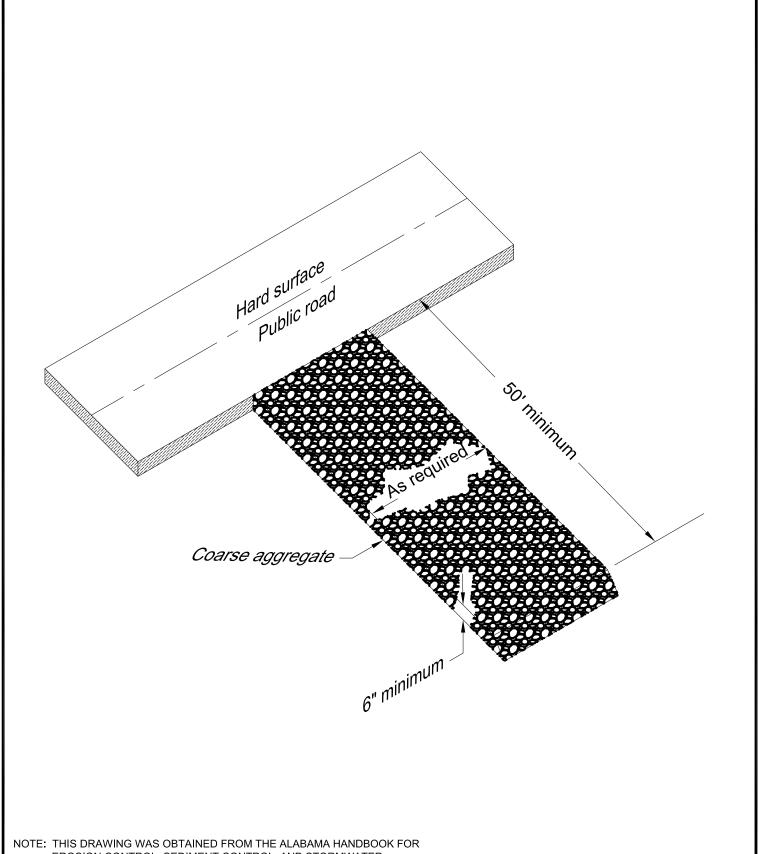


EROSION CONTROL, SEDIMENT CONTROL, AND STORMWATER MANAGEMENT ON CONSTRUCTION SITES AND URBAN AREAS




CITY OF PRATTVILLE STORM WATER MANAGEMENT PROGRAM (SWMP)

DATE 10 APRIL 2018		DRAWING NO.
PREPARED BY D. SMITH	Hydro Engineering Solutions	
APPROVED BY .I I ARKIN		

CEP-1

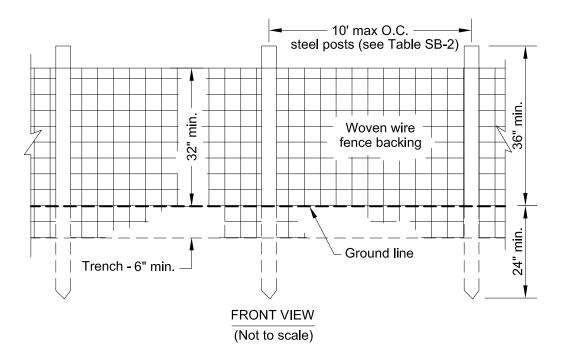

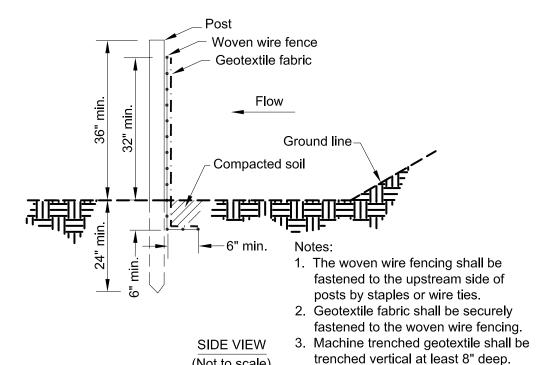

(Not to scale)


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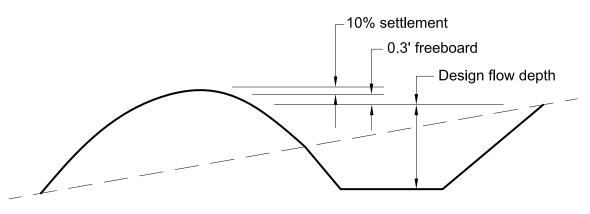


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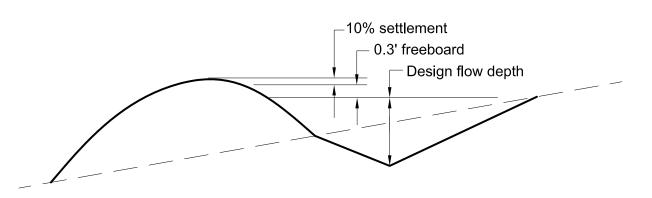
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D. SMITH APPROVED BY J. LARKIN

SB-1



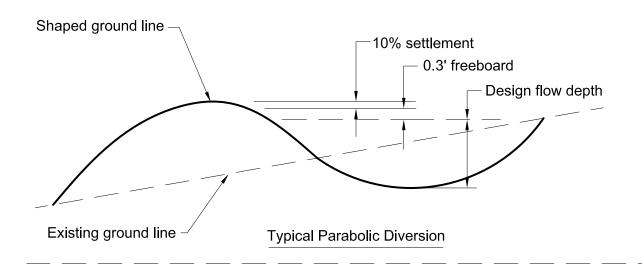

Typical Trapezoidal Diversion



Typical Vee-shaped Diversion

NOTE: THIS DRAWING WAS OBTAINED FROM THE ALABAMA HANDBOOK FOR EROSION CONTROL, SEDIMENT CONTROL, AND STORMWATER MANAGEMENT ON CONSTRUCTION SITES AND URBAN AREAS




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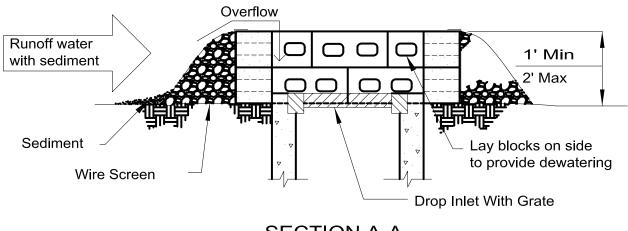
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APPROVED BY J. LARKIN	

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DV-1



PLAN VIEW

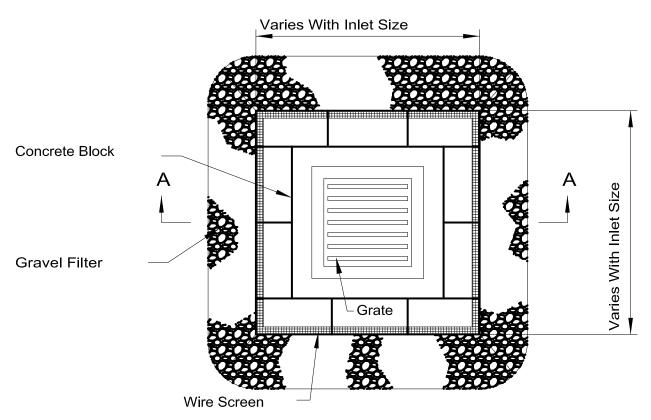

SECTION A-A

Detail is adapted from Illinois NRCS Standard Drawing No. IL-550.

NOTE: THIS DRAWING WAS OBTAINED FROM THE ALABAMA HANDBOOK FOR EROSION CONTROL, SEDIMENT CONTROL, AND STORMWATER MANAGEMENT ON CONSTRUCTION SITES AND URBAN AREAS




CITY OF PRATTVILLE STORM WATER MANAGEMENT PROGRAM (SWMP) DATE
10 APRIL 2018

PREPARED BY
D. SMITH

APPROVED BY
J. LARKIN


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RAWING TITLE TYPICAL DETAILS OF BLOCK AND GRAVEL INLET PROTECTION

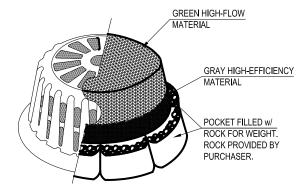


ISOMETRIC VIEW

SHOWN WITH ROADWAY PROJECTS FILTER HAT

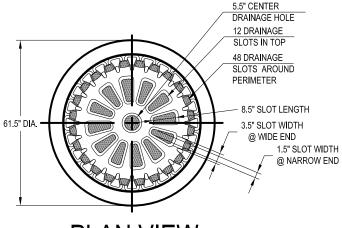

PLAN VIEW

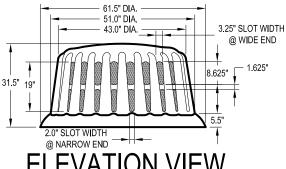

EVATION VIEW

REPLACEMENT FILTERS: MODEL # R-140



ROUND FRAME & FILTER ASSEMBLY Model # R-100A

FILTER OPTIONS

FILTER HAT IS AVAILABLE IN THREE OPTIONS:

1) ALL HIGH-FLOW MATERIAL

2) ALL HIGH-EFFICIENCY MATERIAL

3) HIGH-FLOW MATERIAL ON TOP HALF OF HAT, HIGH-EFFICIENCY MATERIAL ON BOTTOM HALF (THIS FILTER COVER IS RECOMMENDED FOR ALL ROADWAY PROJECTS.)

IT IS THE PURCHASERS RESPONSIBILITY TO PURCHASE APPROPRIATE FILTER HAT. PURCHASER SHALL PROVIDE ROCK FOR FILTER POCKETS.

FILTER HAT INSTALLATION


FILTER HAT SLIDES DIRECTLY OVER FILTER FRAME. TO KEEP FILTER FRAME IN PLACE OVER STORM STRUCTURE, ROCK POCKETS ARE SEWN DIRECTLY INTO FILTER HAT MATERIAL. EVERY FILTER HAT COMES IN ONE PIECE FOR EASY INSTALLATION.

MAINTENANCE

ALL TEMPORARY EROSION, SEDIMENTATION, & POLLUTION CONTROL PRACTICES SHOULD BE INSPECTED DAILY. CONTRACTOR SHALL REMOVE SEDIMENT AND DISPOSE OF IN A PROPER MANNER. INSPECT R-100A DAILY FOR CUTS. ABRASIONS. AND PROPER INSTALLATION. REPLACE OR REPOSITION AS NECESSARY.

SPECIFICATIONS

FILTER FABRIC SILT-SAVER HAT SHALL BE BASED ON DESIGN PROFESSIONAL'S SPECIFICATIONS.

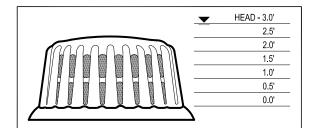

FRAME & FILTER DISCHARGE ANALYSIS

HEAD (FT)	EQUATION	OPENING	FRAME	FILTER	FILTERED
	USED	AREA (SF)	FLOW (CFS)	AREA (SF)	FLOW (CFS)
0.5	0	2.1	7	6	2
1.0	0	3.9	19	12	3
1.5	0	7.0	41	18	5
2.0	0	8.0	54	24	7
2.5	0	9.2	70	30	9
3.0	0	9.2	77		77

DUE TO NARROW SLOT, A TRANSITION WILL OCCUR BETWEEN WEIR AND ORIFICE CONDITIONS. ORIFICE FLOW WILL PROVIDE A MORE CONSERVATIVE ESTIMATE OF FLOW. THEREFORE THE LESSER OF THE ORIFICE AND WEIR FLOWS WILL BE USED FOR EACH STAGE CALCULATION.

FILTER MATERIAL ALLOWS 129 gpm/SF OR 0.29cfs/SF ORIFICE EQUATION (O) = Q=0.6A(2gh)^0.5

P = FEET PERIMETER

h = HEAD IN FEET

Q = CAPACITY IN cfs

A = FREE OPEN AREA OF FRAME

g = 32.2 FEET-PER-SECOND/SECOND

FRAME MATERIAL: BLACK 0,25" HMWPE FILTER FABRIC MATERIAL: REFER TO SPEC

SCALE: NOT TO SCALE LAST UPDATED: APRIL 2010





CITY OF PRATTVILLE STORM WATER MANAGEMENT PROGRAM (SWMP)

10 APRIL 2018 PREPARED BY D. SMITH APPROVED BY J. LARKIN

DRAWING NO.

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NOTES:

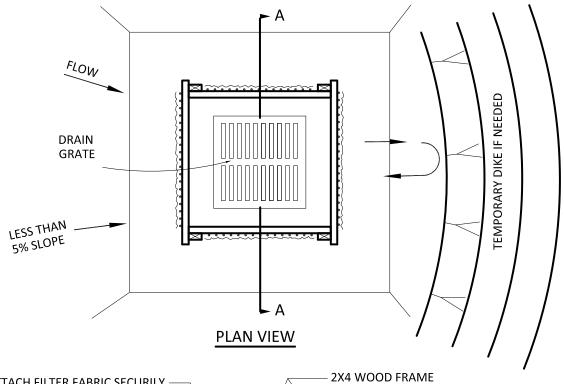- 1. DROP INLET SEDIMENT BARRIERS ARE TO BE USED FOR SMALL, NEARLY LEVEL DRAINAGE AREAS. (LESS THAN 5%)
- 2. USE 2"x4" WOOD OR EQUIVALENT METAL STAKES, 4' MINIMUM LENGTH.
- 3. INSTALL 2"x4" WOOD TOP FRAME TO INSURE STABILITY.
- 4. THE TOP OF THE FRAME (PONDING HEIGHT) MUST BE WELL BELOW THE GROUND ELEVATION DOWNSLOPE TO PREVENT RUNOFF FROM BYPASSING THE INLET. A TEMPORARY DIKE MAY BE NECESSARY IN THE DOWNSLOPES SIDE OF THE STRUCTURE.

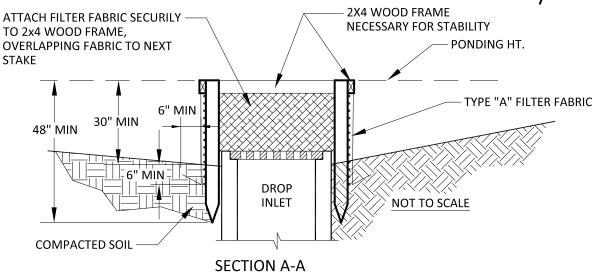


CITY OF PRATTVILLE STORM WATER MANAGEMENT PROGRAM (SWMP) DATE
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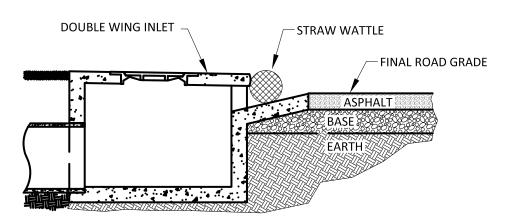
PREPARED BY
D. SMITH

APPROVED BY
J. LARKIN

IPSB-1

DRAWING NO.



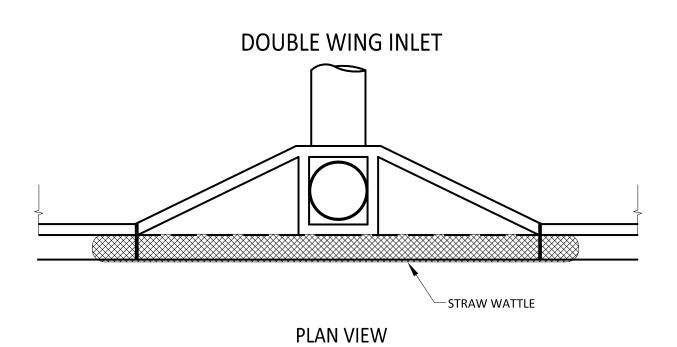

PROFILE VIEW

NOTE:

1. TYPE OF INLET MAY DIFFER, BUT WATTLE MUST BE LONGER THAN INLET TO ENSURE PROPER PROTECTION.



CITY OF PRATTVILLE STORM WATER MANAGEMENT PROGRAM (SWMP)

DATE 10 APRIL 2018	
PREPARED BY D. SMITH	Hendineering Solutions
APPROVED BY J. LARKIN	

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Attachment E

Checklist guide for preparation of an Erosion and Sediment Control Plan



Grading Permit Application Packet

CHECKLIST CONSTRUCTION BEST MANAGEMENT PRACTICES (CBMP) PLANS

Minimum Standards – CBMP Plans shall be developed in accordance with the latest version of the *Alabama Handbook for Erosion Control, Sediment Control and Stormwater Management on Construction Sites and Urban Areas.*

COMPONENTS of NARRATIVE:

Project Description: Briefly describes the nature and purpose of the land-disturbing activity and the area (acres) to be disturbed.
Vicinity map: A small map locating the site in relation to the surrounding area.
Indicate north: The direction of north in relation to the site along with the plan scale.
Existing site conditions: A description of the existing topography, vegetation and drainage.
Limits of clearing and grading: Areas which are to be cleared and graded
Existing contours: The existing contours of the site
Final contours: Changes to the existing contours, including final drainage patterns
Existing Vegetation: The existing tree lines, grassed areas, or unique vegetation described.
Buffers: Provide a 25-foot natural riparian buffer or equivalent sediment controls to all waters of the state.
Adjacent Areas: A description of neighboring areas such as streams, lakes, residential areas roads, etc., which might be affected by the land disturbance.
Off-site areas: Describe any off-site land-disturbing activities that shall occur (including borrow sites, waste or surplus areas, etc.). Will any other areas be disturbed?
Soils: A brief description of the soils on the site giving such information as soil name, mapping unit, erodibility, permeability, depth, texture and soil structure.
Critical Areas: A description of areas on the site which have potentially serious erosion problems (e.g., steep slopes, channels, wet weather/underground springs, etc.).
Erosion and sediment control measures: A description of the methods, which shall be used to control erosion and sedimentation on the site.
Permanent Stabilization: A brief description, including specifications, of how the site shall be stabilized after construction is completed
Stormwater runoff considerations: Will the development site cause an increase in peak runoff rates?
Calculations: Calculations for the design of temporary sediment basins, permanent stormwater detention basins, diversions, channels, etc. Include calculations for pre- and post- developmen runoff.
Landmarks: Include any landmarks, which might assist in locating the site.



Attachment F

Corporate Surety Bond forms (Only one of two required)



Grading Permit Application Packet

SITE CLEARING, EARTHWORK, GRADING, AND OTHER SITE ACTIVITY PERFORMANCE BOND

BOND NUMBER
KNOW ALL MEN BY THESE PRESENTS, THAT WE
(hereinafter called the Principal) and
(hereinafter called the Surety) are held firmly unto the City of Prattville, Alabama (hereinafter called the Obligee), in full and just
sum of
WHEREAS, said Principal has applied to the Obligee for a permit to perform site clearing, earthwork, grading, and other site activity on the land as described as follows:
ste activity on the land as described as follows:
NOW THEREFORE, THE CONDITION OF THIS OBLIGATION IS SUCH THAT, if Principal shall promptly and faithfully construct the improvements and achieve permanent site stabilization in accordance with the approved erosion and sedimentation plans which are made a part hereof by reference as if set out in here full, and said construction approved by Obligee, then the Bond shall be null and void; otherwise to remain in full force and effect. The bond will automatically extend without amendment for additional one year period from the expiration date, or any future expiration date, until all disturbed areas have been permanently stabilized in accordance with approved erosion and sedimentation plans.
WHENEVER, the Principal shall be, and is declared by Obligee to be in default under this agreement, the Surety may promptly remedy the default; or shall promptly:
 Complete the permanent site stabilization, or Obtain a bid for submission to Obligee for complete and permanent site stabilization and upon determination by Obligee and Surety of the lowest responsible bidder, arrange for a contract between such bidder and Obligee and make available as work progresses sufficient funds to pay the cost not to exceed the cost for which the Surety may be liable hereunder, the amount of thisbond.
No right of action shall accrue on this bond to or for the use of any persons or corporation other than the Obligee named herein.
SIGNED, SEALED AND DELIVERED THIS of,
PRINCIPAL (COMPANY NAME) ADDRESS
TELEPHONE NUMBER
FAX NUMBER
OFFICIAL SIGNATURE
SURETY (COMPANY NAME)
ADDRESS
TELEPHONE NUMBER
FAX NUMBER
OFFICIAL SIGNATURE



Grading Permit Application Packet

CITY OF PRATTVILLE, ALABAMA SITE CLEARING ACTIVITY ONLY PERFORMANCE BOND

]	BOND NU	MBER			
KNO (hereinafter cal Prattville, just sum of lawful money of	W ALL ME lled the Prin Alaban	EN BY T ncipal) ar na	HESE PRE nd(hereinaf	SENTS.	, THAT calle	WE(hereinafte d tl Dollars (\$	r called ne	the Surety) Obligee),) are h	eld firmly in	unto th	e City of and
lawful money administrators.									made,	we bind ou	ırselves,	our heirs,
WHE other site activ			oal has applescribed as fo							ing, earthv	vork, gra	ding, and
sedimentation	control	BMPs	in accorda	nce w	ith the	approved	erosio	_, provided n and see	the Pri diment	ncipal inst ation pla City Plannin	all the erens preparting	osion and pared by ment.
NOW faithfully cons sedimentation then the Bond amendment for been permanen	truct the ir plans which shall be no additional	nprovem n are mad all and v one yea	de a part her oid; otherw r period fro	chieve pore coff by records to records to records the extended to the extended	ermane eference emain in xpiration	nt site stab as if set out full force date, or a	ilization in here f and effec ny future	in accordanull, and said tt. The bone expiration	nce wit d constr d will a	th the appropriection appropriection appropriection	roved ero proved by ally exten	osion and Obligee, d without
promptly reme 1. Compl 2. Obtain and Su as wor the am	dy the defa lete the per a a bid for su arety of the k progresse aount of this	mult; or sl manent; abmissio lowest re es suffici sbond.	site stabiliz in to Obligee esponsible b ient funds to	ly: eation, or e for com oidder, a o pay the	r nplete an arrange f e cost no	d permane or a contract of to exceed	ent site st et betwee the cost	abilization on such bide for which	and up der and the Sur	oon determ Obligee a ety may bo	ination b nd make e liable h	y Obligee available ereunder,
No right of act						• •		-				
		AND DE	LIVERED	THIS		day_			oi	,	·	
PRINCIPA (COMPAN	AL NY NAME))										
ADDRESS	S											
TELEPHO	ONE NUMI	BER										
FAX NUM	/IBER											
OFFICIAI	L SIGNATI	URE										
SURETY NAME) ADDRESS	(COMPA)	NY										
TEL EPHO	ONE NUMI	RER										
FAX NUM												
OFFICIAI	L SIGNATU	URE										



Attachment G

Site Clearing, Earthwork, Grading and other Site Activity Letter of Credit Form



Grading Permit Application Packet

ISSULDA	TE:	
STATED I	EXPIRATION DATE: _	
IN FAVOI	ROF:	FOR ACCOUNT OF:
City of Prattville, Alabama Attn: Planning Department 102 West Main Street		Name of Property Owner
	Alabama 36067	Address
		Telephone Number:
То	the City of Prattville, Al	abama:
_		
("Beneficial ("Custome (\$	Credit No (the arry") for the account of r") in an amount not exceed by draft drawn on Islands at Issuer's of fice a	(the "Issuer") hereby establishes its Irrevocable Standby is "Letter of Credit") in favor of the City of Prattville, Alabama eeeding
("Beneficial ("Custome (\$	Credit No (the arry") for the account of r") in an amount not exceed the account of exceeding the arry by draft drawn on Islablic at Issuer's of fice a	reeding U.S. Dollars the aggregate (the "Stated Amount"). These funds shall be available assuer at sight during hours on which Issuer is open for doing business
("Beneficial ("Custome (\$	Credit No (the arry") for the account of r") in an amount not exceed the account of the account of exceeding the account of the account	reeding
("Beneficial ("Custome (\$	Credit No (the ary") for the account of r") in an amount not exceed the account of the account of exceeding the account of the account	reeding
("Beneficial ("Custome (\$	Credit No (the ary") for the account of r") in an amount not exceed the account of the acc	reeding
("Beneficial ("Custome (\$	Credit No (the ary") for the account of r") in an amount not exceed the account of the acc	reeding

Credit (such notice being call a "Notice of Non-Renewal). On the expiration date immediately following delivery of said Notice of Non-Renewal to Beneficiary, this Letter of Credit will expire and Issuer shall



Grading Permit Application Packet

be fully discharged of all obligations under this Letter of Credit.

This Letter of Credit may be terminated with written approval from the City of Prattville. Said approval not to be unreasonably withheld.

Partial drawings are **not** permitted under this Letter of Credit.

This Letter of Credit is non-transferrable, and no valid transfer or assignment hereof shall be authorized or permitted.

This Letter of Credit is subject to the *International Standby Practices* ("ISP98") published by the International Chamber of Commerce, which is made a part hereof by this reference; and to the extent not inconsistent with the ISP98, this Letter of Credit shall be governed by and construed in accordance with the laws of the State of Alabama, U.S.A.

This Letter of Credit must be presented with any drawing.

ISSUER NAME: ADDRESS:				-	
Prattville, AL				- -	
	D		Bank Nam	ne	
	B	y	Name, Titl	le	